WHERE APPLICABLE BY TRADE, SUBCONTRACTORS.

W Montana S


Corsini Stark Architects, LLP 3630 Tyburn Street

> Los Angeles, CA 90065 t 323 255 9100

f 323 255 9105 w corsinistark.com

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SUBMISSIONS / REVISIONS OAK TREE PERMIT SUBMITTAL 06.25.2014 SITE PLAN REVIEW SUBMITTAL 07.03.2014 PLAN CHECK SUBMITTAL 08.27.2014 GRADING SUBMITTAL 08.28.2014 OAK TREE PERMIT RESUBMITTAL 09.24.2014 FIRE PREVENTION DIVISION SUBMITTAL 11.18.2014 GEOTECH & MATERIALS DIVISION SUBMITTAL 11.18.2014 SITE PLAN REVIEW RESUBMITTAL GRADING RESUBMITTAL 12.04.201 PLAN CHECK RESUBMITTAL 12.09.2014 SITE PLAN REVIEW RESUBMITTAL 12.16.2014 FIRE PREVENTION DIVISION RESUBMITTAL 12.18.2014 SITE PLAN / OAK TREE REVIEW RESUBMITTAL 12.24.201 COUNTY SANITATION DISTRICT SUBMITTAL LAND DEVELOPMENT DEPARTMENT SUBMITTAL 01 13 2015

DRIVEWAY SUBMITTAI

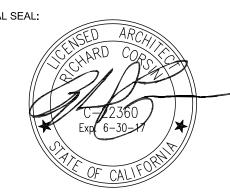PROJECT TITLE:

RETAINING WALL SUBMITTAI

FOUNDATION PERMIT SUBMITTAL

BS FENCE REVISION SUBMITTAL

PLANNING FENCE REVISION SUBMITTAL

1200 E. WOODBURY RD

DRAWING TITLE:

DRAWING NUMBER

A0.01

PROJECT 14.000.06

- 1. THE WORD "CONTRACTOR" MEANS THE GENERAL CONTRACTOR AND, 24. THE CONTRACTOR SHALL KEEP THE PREMISES AND SURROUNDING AREA FREE FROM ACCUMULATION OF WASTE MATERIALS OR RUBBISH CAUSED BY OPERATIONS UNDER THE CONTRACT. AT COMPLETION OF THE WORK THE CONTRACTOR SHALL REMOVE FROM AND ABOUT THE PROJECT WASTE MATERIALS, RUBBISH, THE CONTRACTOR'S TOOLS, CONSTRUCTION
- 2. CONTRACTOR SHALL BE RESPONSIBLE FOR VIEWING ALL NOTES PRIOR TO FINALIZING CONSTRUCTION CONTRACT. 3. THE CONTRACTOR SHALL COMPLY WITH ALL APPLICABLE CODES INCLUDING
- BUT NOT LIMITED TO THE LATEST EDITIONS OF THE LOCAL BUILDING CODE, NATIONAL ELECTRICAL CODE, UNIFORM PLUMBING AND MECHANICAL CODES AND ANY APPLICABLE STATE AND LOCAL CODES. THE GENERAL CONTRACTOR SHALL MAINTAIN AT THE SITE ONE RECORD COPY OF THE DRAWINGS, SPECIFICATION, ADDENDA, CHANGE ORDERS AND OTHER MODIFICATION IN GOOD ORDER AND MARKED CURRENT TO RECORD CHANGES AND SELECTIONS MADE DURING CONSTRUCTION, AND IN ADDITION APPROVED SHOP DRAWINGS, PRODUCT DATA, SAMPLES AND SIMILAR REQUIRED MATERIALS.
- CONTRACTOR SHALL VERIFY ALL WORK, DIMENSIONS AND DETAILS AND REPORT ANY DISCREPANCIES TO THE OWNER AND ARCHITECT PRIOR TO COMMENCING WORK. DURING CONSTRUCTION THE ARCHITECT IS ALSO TO BE ADVISED REGARDING ANY DISCREPANCIES IN MEASUREMENT, DIMENSIONS, LOCATIONS OR DETAILS PRIOR TO CONTRACTOR'S PROCEEDING WITH THAT PORTION OF WORK. ALL EXISTING CONSTRUCTION TO REMAIN SHALL BE VERIFIED FOR SQUARE IN LAYOUT AND PLUMB IN VERTICAL CONSTRUCTION. ERRORS, INCONSISTENCIES OR OMISSIONS DISCOVERED SHALL BE REPORTED TO CORSINI ARCHITECTS AT ONCE.
- WRITTEN DIMENSIONS SHALL PREVAIL OVER SCALED DIMENSIONS ON DRAWINGS. IN NO EVENT IS A DIMENSION TO BE SCALED OFF A DRAWINGS WITHOUT FIRST ADVISING THE ARCHITECT.
- PRIOR TO FINALIZING CONTRACT PRICES. CONTRACTOR SHALL BE RESPONSIBLE FOR REVIEWING AND COORDINATING ALL NOTES AND DRAWINGS TO INCLUDE ANY SUBCONTRACT REQUIREMENTS OR INFORMATION WHICH MAY NOT BE INDICATED ON SUBCONTRACTOR'S SHEETS OR NOTES, BUT WHICH ARE INDICATED ELSEWHERE IN THE CONSTRUCTION DOCUMENTS.
- DETAILS ARE INTENDED TO SHOW THE FINAL EFFECT OF PARTS OF CONSTRUCTION. MINOR MODIFICATIONS MAYBE REQUIRED TO SUIT PARTICULAR JOB SITE DIMENSIONS OR CONDITIONS AND SHALL BE INCLUDED WITHIN THE SCOPE OF THE WORK. ANY MODIFICATIONS REQUIRED ARE TO BE FIRST REVIEWED AND CONFIRMED WITH THE ARCHITECT PRIOR TO CONSTRUCTION.
- CONTRACTOR SHALL KEEP PREMISES SECURE, CLEAN AND HAZARD FREE. CONTRACTOR SHALL BE RESPONSIBLE FOR MAINTAINING HIS EQUIPMENT, MATERIALS, AND WORK IN NEAT, CLEAN, ORDERLY, AND SAFE CONDITION AT ALL TIMES.
- CONTRACTOR SHALL ERECT AND MAINTAIN TEMPORARY BARRICADES AND DUST-PROOF PARTITIONS AS NEEDED FOR PROTECTION AGAINST ACCIDENT, AND SHALL CONTINUOUSLY MAINTAIN ADEQUATE PROTECTION OF HIS WORK AND THE OWNER'S PROPERTY FROM DAMAGE OR LOSS ARISING IN CONNECTION WITH CONSTRUCTION.
- CONTRACTOR SHALL DEMOLISH EXISTING CONSTRUCTION AS NECESSARY TO INSTALL NEW WORK, AND REMOVE ALL EXCESS DEBRIS AND MATERIALS, NOT REQUIRED BY CONSTRUCTION OR REQUESTED BY OWNER.
- CONTRACTOR SHALL REVIEW ALL ITEMS NOTED "VERIFY" WHICH MIGHT AFFECT COSTS PRIOR TO FINALIZING CONSTRUCTION CONTRACT AND SUBCONTRACTS, AND SHALL CONFIRM FINAL DECISIONS REGARDING SELECTION, MATERIALS, COLOR, FINISH, OR OTHER SPECIFICATIONS NOT YET DECIDED REGARDING THESE ITEMS. CONTRACTOR SHALL INCLUDE THE COSTS OF THESE ITEMS WITHIN THE FINAL CONTRACT PRICE.
- UNLESS ITEMS ARE SPECIFICALLY ITEMIZED AS NOT INCLUDED IN CONTRACT (N.I.C.) THEY WILL BE ASSUMED TO BE INCLUDED IN THE ESTIMATE OR CONTRACT PRICE.
- 13. ALL ALLOWANCE ITEMS SHALL BE SPECIFICALLY IDENTIFIED AS ALLOWANCES AND INCLUDED IN THE CONTRACT PRICE.
- 14 CONTRACTOR SHALL IMMEDIATELY NOTIFY THE OWNER AND THE ARCHITECT OF ANY EXTRA COSTS ARISING FROM THE EXECUTION OF HIS CONTRACT OR SUBCONTRACTS AND SHALL RECEIVE OWNER'S WRITTEN APPROVAL OF EXTRA COSTS PRIOR TO COMMENCING THE WORK.
- 5 CONTRACTOR SHALL IMMEDIATELY NOTIFY THE OWNER AND ARCHITECT IN WRITING OF ANY DELAYS OR CHANGES IN SCHEDULE AND RECEIVE OWNER'S WRITTEN APPROVAL OF SAME.
- CONTRACTOR SHALL BE RESPONSIBLE FOR SUPERVISING THAT ALL GENERAL AND SUBCONTRACT WORK IS BEING ACCOMPLISHED ACCORDING TO THE MOST CURRENT CONSTRUCTION DOCUMENTS, INCLUDING REVISIONS
- 7. UNLESS OTHER ARRANGEMENTS ARE MADE, OWNER SHALL PROVIDE ADEQUATE PROPERTY AND LIABILITY INSURANCE IN ADDITION TO CONTRACTOR'S INSURANCE TO COVER ALL NEW WORK. THIS INSURANCE SHALL INCLUDE THE INTERESTS OF THE OWNER AND CONTRACTOR IN THE WORK, BUT SHALL NOT RELIEVE CONTRACTOR OF HIS RESPONSIBILITIES UNDER THE CONTRACT OR AS ITEMIZED ABOVE.
- 18 CONTRACTOR TO NOTIFY OWNER AND ARCHITECT AT TIME OF ARRIVAL OF ANY DAMAGED OWNER-SUPPLIED MATERIALS.
- 19. CONTRACTOR SHALL PROVIDE TEMPORARY TOILET FACILITIES ON THE JOB
- THE WORKING DRAWINGS AND SPECIFICATIONS REPRESENT THE FINISHED PROJECT AND DO NOT INDICATE METHODS OF CONSTRUCTION. THE CONTRACTOR SHALL SUPERVISE AND DIRECT THE WORK AND SHALL BE SOLELY RESPONSIBLE FOR CONSTRUCTION MEANS, METHODS, TECHNIQUES AND SHORING. OBSERVATION VISITS TO THE SITE BY FIELD REPRESENTATIVES OF CORSINI ARCHITECTS SHALL NOT INCLUDE INSPECTIONS OF THE PROTECTIVE MEASURES OR THE CONSTRUCTION PROCEDURES. ANY SUPPORT SERVICES PERFORMED BY CORSINI ARCHITECTS DURING THE CONSTRUCTION SHALL BE DISTINGUISHED FROM CONTINUOUS AND DETAILED INSPECTION SERVICES WHICH IS FURNISHED BY OTHERS. THESE SUPPORT SERVICES PERFORMED BY CORSINI ARCHITECTS, WHETHER OF MATERIAL WORK, AND WHETHER PERFORMED PRIOR TO, DURING OR AFTER COMPLETION OF CONSTRUCTION, ARE PERFORMED SOLELY FOR THE PURPOSE OF ASSISTING IN QUALITY CONTROL AND IN ACHIEVING GENERAL CONFORMITY WITH THE CONSTRUCTION DOCUMENTS, BUT DO NOT GUARANTEE THE CONTRACTOR'S PERFORMANCE AND SHALL NOT BE CONSTRUCTED AS SUPERVISION OF CONSTRUCTION.
- THE CONTRACTOR SHALL REVIEW, APPROVE AND SUBMIT TO CORSINI ARCHITECTS SHOP DRAWINGS, PRODUCT DATA, SAMPLES AND SIMILAR SUBMITTALS REQUIRED BY THE CONSTRUCTION DOCUMENTS WITH REASONABLE PROMPTNESS AND VIN SUCH SEQUENCE AS TO CAUSE NO DELAY IN THE WORK OR ACTIVITIES OF THE OWNER OR OF SEPARATE CONTRACTORS.
- 2 SUBMITTALS AND/OR SHOP DRAWINGS ARE REQUIRED FOR THE FOLLOWING: ALL DESIGN-BUILD PLUMBING, MECHANICAL, AND ELECTRICAL WORK. INCLUDING PRODUCT DATA FOR EQUIPMENT AND FIXTURES. ROOFING, CONCRETE BLOCK, INTEGRALLY-COLORED CONCRETE, EXTERIOR PLASTER,

GATES, AND DOOR HARDWARE.

THE CONTRACTOR SHALL CONFINE OPERATIONS AT THE SITE TO AREAS PERMITTED BY LAW. ORDINANCES. PERMITS AND THE CONSTRUCTION DOCUMENTS AND SHALL NOT UNREASONABLY ENCUMBER THE SITE WITH MATERIAL OR EQUIPMENT.

PAINT, SEALERS AND COATINGS, PLASTIC LAMINATE, FINISH MILLWORK, CERAMIC TILE, ALUMINUM STOREFRONT, CUSTOM NEON SIGNAGE, ALLEY

- EQUIPMENT, MACHINERY AND SURPLUS MATERIALS.
- 25. THE CONTRACTOR SHALL PROVIDE THE OWNER AND CORSINI ARCHITECTS ACCESS TO THE WORK IN PREPARATION AND PROGRESS WHEREVER
- 26. THE CONTRACTOR SHALL BE RESPONSIBLE FOR INITIATING, MAINTAINING AND SUPERVISING ALL SAFETY PRECAUTIONS AND PROGRAMS IN CONNECTION WITH THE PERFORMANCE OF THE CONTRACT.
- 27. THE CONTRACTOR SHALL TAKE REASONABLE PRECAUTIONS FOR SAFETY OF, AND SHALL PROVIDE REASONABLE PROTECTION TO PREVENT DAMAGE, INJURY OR LOSS TO: A. EMPLOYEES ON THE WORK AND OTHER PERSONS WHO MIGHT BE
- AFFECTED THEREBY. B. THE WORK AND MATERIALS AND EQUIPMENT TO BE INCORPORATED THEREIN.
- C. OTHER PROPERTY AT THE SITE OR ADJACENT THERETO, SUCH AS TREES, SHRUBS, LAWNS, WALKS, PAVEMENTS, ROADWAYS, STRUCTURES AND UTILITIES NOT DESIGNATED FOR REMOVAL, RELOCATION, OR REPLACEMENT ON THE COURSE OF CONSTRUCTION.
- 28. THE CONTRACTOR SHALL BE RESPONSIBLE FOR THE SAFETY OF THE BUILDING. THE CONTRACTOR SHALL PROVIDE ADEQUATE SHORING, BRACING AND GUYS IN ACCORDANCE WITH ALL NATIONAL, STATE AND LOCAL SAFETY ORDINANCES.
- 29. IF A PORTION OF THE WORK IS COVERED CONTRARY TO THE REQUEST OF CORSINI ARCHITECTS, OR TO THE REQUIREMENTS SPECIFICALLY EXPRESSED IN THE CONSTRUCTION DOCUMENTS, IT MUST, IF REQUIRED IN WRITING BY CORSINI ARCHITECTS BE UNCOVERED FOR OBSERVATION OF CORSINI ARCHITECTS.
- 30. THE CONTRACTOR SHALL PROMPTLY CORRECT WORK REJECTED BY CORSINI ARCHITECTS OR FAILING TO CONFORM TO THE REQUIREMENTS OF THE CONSTRUCTION DOCUMENTS, WHETHER OBSERVED BEFORE OR AFTER SUBSTANTIAL COMPLETION AND WHETHER OR NOT FABRICATED INSTALLED OR COMPLETED. THE CONTRACTOR SHALL BEAR COSTS OF CORRECTING SUCH REJECTED WORK, INCLUDING ADDITIONAL TESTING AND INSPECTIONS AND COMPENSATION FOR THE SERVICES AND EXPENSE OF CORSINI ARCHITECTS MADE NECESSARY THEREBY.

FRAMING:

- PRIOR TO FORMING AND POURING CONCRETE, CONTRACTOR SHALL STAKE OUT ALL FOUNDATIONS AND PERIMETER WALL LINES AS SHOWN ON PLANS FOR ARCHITECT'S REVIEW, CONFIRM EXISTING STRUCTURE AND PROPERTY LINE LOCATIONS, AND VERIFY PROPER SETBACKS AND CLEARANCES REQUIRED BY LOCAL CODES.
- 2. THERE SHALL BE NO TRENCHES OR EXCAVATIONS 5 FEET OR MORE IN DEPTH INTO WHICH A PERSON IS REQUIRED TO DESCEND, OR OBTAIN NECESSARY PERMIT FROM THE STATE OF CALIFORNIA DIVISION OF INDUSTRIAL SAFETY PRIOR TO ISSUANCE OF A BUILDING OR GRADING PERMIT. (HSC 17922.5, EFF. 2/6/76)
- CONTRACTOR SHALL PROVIDE CRAWL SPACE ACCESS AND VENTILATION IN ACCORDANCE WITH LOCAL CODES AND SHALL NOTIFY ARCHITECT OF ANY CHANGES TO THE DRAWINGS.
- 4. ANY LANDSCAPE OR PLANTER RETAINING WALLS WHICH ARE SPECIFIED WITHOUT PERIMETER DRAINS SHALL BE PROVIDED WITH ADEQUATE WEEP HOLES AT BASE OF WALL.
- 5. ALL CONCRETE SLABS TO BE PARTIALLY REMOVED SHALL FIRST BE NEATLY
- 6. PATCHING OF CONCRETE SLABS SHALL BE PERFORMED SO AS TO LEAVE THE PATCH SURFACE SMOOTH, LEVEL, AND TIGHTLY JOINED TO THE EXISTING SLAB.
- 7. CONTRACTOR SHALL PROVIDE POSITIVE DRAINAGE OF ALL FINISHED GRADE SURFACES, SIDEWALKS, AND PATIOS AWAY FROM STRUCTURES AND VERIFY THAT ALL AREAS AFFECTED BY CONSTRUCTION ARE PROPERLY DRAINED, WITH NO PONDING.
- 8. GENERAL CONTRACTOR SHALL PROTECT AND MAINTAIN EXISTING TREES AND LANDSCAPING WHICH DO NOT CONFLICT WITH NEW CONSTRUCTION, AND SHALL ADVISE OWNER PRIOR TO CONSTRUCTION OF ANY LANDSCAPING TO BE REMOVED.
- 9. CONTRACTOR SHALL REMOVE ALL EXCAVATED OR EXCESS SOIL, DEBRIS AND MATERIALS NOT REQUIRED TO CONSTRUCTION. CONFIRM ANY ITEMS TO REMAIN WITH ARCHITECT AND OWNER PRIOR TO START OF CONSTRUCTION.
- 10 COMPLETE NEW LANDSCAPING AND AUTOMATIC SPRINKLER SYSTEM OR SEVEN DAY TIME CLOCK BY OTHER. GENERAL CONTRACTOR TO COORDINATE DRAINAGE LINES AND FINAL CONSTRUCTION NOT TO DISRUPT THIS WORK. (VERIFY W/ OWNER)
- 11. SEE STRUCTURAL NOTES AND DRAWINGS FOR ADDITIONAL INFORMATION.

GENERAL NOTES: SECURITY

- ALL OPENINGS MARKED ARE SECURITY OPENINGS, AND THE FOLLOWING
- NOTES SHALL APPLY:
 - SWINGING DOORS A) DOOR STOPS OF IN-SWINGING DOORS SHALL BE OF ONE-PIECE CONSTRUCTION WITH THE JAMB OR JOINED BY RABBET TO THE JAMB.
 - B) ALL PIN-TYPE HINGES WHICH ARE ACCESSIBLE FROM OUTSIDE THE SECURD AREA WHEN THE DOOR IS CLOSED SHALL HAVE NON-REMOVABLE HINGE PINS. IN ADDITION, THE SHALL HAVE MINIMUM 1/4" DIAMETER STEEL JAMB STUD WITH 1/4" MINIMUM PROJECTION UNLESS THE HINGES ARE SHAPED TO PREVENT REMOVAL OF THE DOOR IF THE HINGE PINS ARE REMOVED.
 - C) THE STRIKE PLATE FOR LATCHES AND THE HOLDING DEVICE FOR PROJECTING DEADBOLTS IN WOOD CONSTRUCTION SHALL BE SECURED TO THE JAMB AND THE WALL FRAMING WITH SCREWS NOT LESS THAN 2-1/2" IN LENGTH.
 - D) DEADBOLTS SHALL CONTAIN HARDENED INSERTS.

WITH SOLID CORE CONSTRUCTION.

- E) STRAIGHT DEADBOLTS SHALL HAVE A MINIMUM THROW OF 1" AND AN EMBEDEMENT OF NOT LESS THAN 5/8".
- F) A HOOK-SHAPED OR AN EXPANDING-LUG DEADBOLT SHALL HAVE A MINIMUM THROW OF 3/4".

G) WOOD FLUSH-TYPE DOORS SHALL BE 1-3/8" THICK MINIMUM

- H) HOLLOW CORE DOORS OR DOORS LESS THAN 1-3/8" IN THICKNESS SHALL BE COVERED ON THE INSIDE FACE WITH 16 GAUGE SHEET METAL ATTACHED WITH SCREWS AT 6" ON CENTERS AROUND THE PERIMETER OR EQUIVALENT.
- I) GLASS DOORS SHALL HAVE FULLY TEMPERED GLASS COMPLYING WITH SECTION 91.1711(d) OF THE LOS ANGELES CITY BUILDING CODE.

- 2. CYLINDER GUARDS SHALL BE INSTALLED ON ALL CYLINDER LOCKS WHENEVER THE CYLINDER PROJECTS BEYOND THE FACE OF THE DOOR OR ITS OTHERWISE ACCESSIBLE TO GRIPPING TOOLS.
- SLIDING GLASS DOORS AND WINDOWS SHALL BE EQUIPPED WITH LOCKING DEVICES AND SHALL BE SO CONSTRUCTED AND INSTALLED THAT THEY REMAIN INTACT AND ENGAGED WHEN SUBJECTED TO THE TESTS SPECIFIED IN 91.6731 AND 91.6732.
- SLIDING DOORS AND WINDOWS SHALL BE PROVIDED WITH A DEVICE IN THE UPPER CHANNEL OF THE MOVING PANEL TO PROHIBIT RAISING AND REMOVING OF THE MOVING PANEL IN THE CLOSED OR PARTIALLY OPEN POSITION.
- LOUVERED WINDOWS SHALL BE PROTECTED BY METAL BARS OR GRILLS WITH OPENINGS THAT HAVE AT LEAST ONE DIMENSION OF 6" OR LESS, WHICH ARE CONSTRUCTED TO PRECLUDE HUMAN ENTRY.
- OTHER OPENABLE WINDOWS SHALL BE PROVIDED WITH SUBSTANTIAL LOCKING DEVICES, IN G OCCUPANCIES, SUCH DEVICES SHALL BE GLIDE BARS, BOLTS, CROSSBARS, AND/OR PADLOCKS WITH MINIMUM 9/32" HARDENED STEEL SHACKLES AND BOLTED HARDENED STEEL CLASPS.
- SCREENS, BARRICADES, OR FENCES MADE OF MATERIAL WHICH PRECLUDE HUMAN CLIMBING SHALL BE PROVIDED AT EVERY PORTION OF EVERY ROOF, BALCONY, OR SIMILAR SURFACE

WHICH IS WITHIN 8' OF A UTILITY POLE OR SIMILAR STRUCTURE.

- 8. EXTEND SECURITY SYSTEM TO NEW FIRST AND SECOND FLOOR DOOR & WINDOWS. PROVIDE KEYPAD ON 2ND FLOOR.
- 9. EVERY EXIT DOOR SHALL BE OPENABLE FROM THE INSIDE WITHOUT THE USE OF A KEY OR ANY SPECIAL KNOWLEDGE OR
- 10. INACTIVE LEAF OF PAIR OF DOORS SHALL BE SECURED WITH MANUALLY OPERATED HARDENED BOLTS AT TOP AND BOTTOM OF LEAF. 1/2" MINIMUM EMBEDMENT.
- 11 ALL GLAZED OPENINGS WITHIN 40" OF DOOR LOCK SHALL BE FULLY TEMPERED.

DESIGN-BUILD NOTES

- ELECTRICAL WORK SHALL BE DESIGN-BUILD AND SHALL CONFORM TO THE REQUIREMENTS SPECIFIED IN THE TITLE 24 REPORT
- MECHANICAL & PLUMBING WORK SHALL BE DESIGN-BUILD AND SHALL CONFORM TO THE REQUIREMENTS SPECIFIED IN THE TITLE 24 REPORT.
- DESIGN FOR COMPLETE MECHANICAL AND ELECTRICAL SYSTEMS SHALL BE SUBMITTED TO ARCHITECT FOR APPROVAL PRIOR TO INSTALLATION.
- FIRE SPRINKLERS SHALL BE DESIGN-BUILD AND SHALL CONFORM TO THE REQUIREMENTS SPECIFIED IN THE TITLE 24, 310.9.1 REGARDING FIRE WARNING SYSTEMS

2014 County of Los Angeles Building Code (Title 26) Based on the 2013 California Building Code and the 2012 International Building

2014 County of Los Angeles Electrical Code (Title 27) Based on the 2013 California Electrical Code and the 2011 National Electrical

2014 County of Los Angeles Plumbing Code (Title 28) Based on the 2013 California Plumbing Code and the 2012 Uniform Plumbing

2014 County of Los Angeles Mechanical Code (Title 29) Based on

2014 County of Los Angeles Residential Code (Title 30) Based on the 2013 California Residential Code and the 2012 International Residential Code

the 2013 California Mechanical Code and the 2012 Uniform

Mechanical Code

2014 County of Los Angeles Green Building Standards Code (Title 31) Based on the 2013 California Green Building Standards Code

PROJECT SUMMARY

E Villa St

Atchison St

E Howard St

E Rio Grande St

E Washington Blvd

F Walnut St F Walnut St

E Elizabeth St

E Orange Grove Blvd

OWNERS: ERIC & ELISA CALLOW 985 ORANGE GROVE BLVD #101 PASADENA, CA 91105

LEGAL DESCRIPTION: 1200 E. WOODBURY ROAD, ALTADENA, CALIFORNIA LOT 2, BRITTON'S TRACT, AS PER MAP RECORDED IN BOOK 13 PAGE 5 OF MAPS RECORDS OF LOS ANGELES

LD

COUNTY. A.P.N.# 5849-015-003 SITE ZONING: R-1-7500 ZONE ALTADENA CSD LAND USE:

TYPE OF CONSTRUCTION: TYPE V-B OCCUPANCY GROUP: TOTAL LOT AREA: 8,262.9 SF

ALLOWED BUILDABLE AREA: 3,065.7 SF BUILDING AREA: GROUND LEVEL: 1,476 SF BASEMENT LEVEL: 929 SF MECHANICAL BASEMENT: TOTAL: 2,653 SF

BUILDING FOOTPRINT: 2,762 SF LOT COVERAGE:

SETBACKS FRONT: 31'-0" (AVERAGE) 5'-6" (10% OF LOT WIDTH 56.05') SIDE:

MAX HT ALLOWED: 30'-0" BLDG. HEIGHT: 21'-0"

YES (NFPA)

NEW DRIVEWAY APPROACH/APRON & NEW DRIVEWAY. DRIVEWAY TO SLOPE/INCLINE FROM SIDEWALK TOWARDS TRASH ENCLOSURE. DRIVEWAY FINISH AT OAK TREE

CANOPY AREAS WILL BE PERMEABLE (PAVERS & GRAVEL)

Altadena Golf Course

1200 E Woodbury Rd

New York Dr

E Washington Blvd

Las Lunas S

E Villa St

SCOPE OF WORK

AND CONCRETE AT REMAINDER OF DRIVEWAY.

oothill Ewy

New York Dr

E Crary St

E Washington B

E Orange Grove Blv

Paloma St

210 28 Foothill Fwy

E Foothill Blvd

Garfias Dr

Galbreth Rd

Brigden Rd

Casa Grande St

PARTIAL RECONFIGURATION OF PERMITTED FENCE ON WEST PROPERTY LINE. TOP OF CMU BLOCK WALL WILL BE RAISED TO 200.72 FROM APPROVED HEIGHT OF 196.21 & FENCE TOPPED WITH STEEL TUBE AND GALVANIZED CABLE GUARDRAIL, RATHER THAN STEEL TUBE & SOLID WOOD PLANKING.

PERMITTED FENCE WORK TO REMAIN PER: PERMIT: RPP 201400711 AMENDMENT PROJECT: R2014-01840

SHEET INDEX

EXISTING CONDITIONS PHOTOGRAPHS

NOTES

ARCHITECTURAL DRAWINGS

A1.00

A3.01

A3.02

A4.01

SITE PLAN

EXTERIOR ELEVATIONS

EXTERIOR ELEVATIONS

SECTION/ELEVATIONS & DETAILS

SECTION/ELEVATIONS & DETAILS

PARKING: 2 SPACES (CARPORT/GARAGE)

P: 818 219 2276

HIGH FIRE:

REAR:

FULLY SPRINKLERED: ITEMS REQUIRING R-1 PERMIT: OAK TREE PERMIT

FRONT AVERAGE SETBACK CALCULATION | L E G E N D

AVERAGE SETBACK

#1138 - 17'-7"

#1148 - 18'-0"

#1162 - 32'-6"

#1176 - 32'-6"

#1184 - 32'-7"

#1188 - 58'-0"

#1200 - 34'-11"

#1212 - 34'-11"

#1220 - 17'-5"

278.4/9 = 30.9'

PROJECT


LOCATION

278'-5"

 $\mapsto N$

SCALE: NTS

CALCULATION

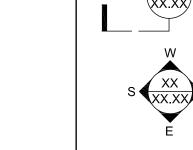

INTERIOR ELEVATION / xx

XX.XX XX

(XX) $\langle xx \rangle$

> • FF-XX • WF-XX

• MF-XX

NORTH ARROW BUILDING SECTION

-|xx|**KEY NOTE**

FLOOR FINISH NUMBER

REVISION NUMBER

• CF-XX MILLWORK FINISH

DETAIL CALLOUT

DETAIL REFERENCE

ROOM NUMBER DOOR NUMBER

WINDOW NUMBER

WALL FINISH NUMBER CEILING FINISH NUMBER

A4.05

ELEVATION INDICATOR MATERIAL CHANGE

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02.09.2015

03.12.2015

04.08.2015

05.11.2015

12.08.2015

CALLOW RESIDENCE

ALTADENA, CA 91104

TITLE SHEET







FRONT ELEVATION FROM WOODBURY RD SHOWING E & W NEIGHBORS



VIEW OF WEST NEIGHBOR FROM REAR YARD



VIEW OF REAR ELEVATION FROM DETACHED GARAGE



VIEW OF REAR YARD FROM HOUSE

CORSINI STARK architects

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#	SUBMISSIONS / REVISIONS	DATE
	OAK TREE PERMIT SUBMITTAL	06.25.2014
	SITE PLAN REVIEW SUBMITTAL	07.03.2014
	PLAN CHECK SUBMITTAL	08.27.2014
	GRADING SUBMITTAL	08.28.2014
	OAK TREE PERMIT RESUBMITTAL	09.24.2014
	FIRE PREVENTION DIVISION SUBMITTAL	11.18.2014
	GEOTECH & MATERIALS DIVISION SUBMITTAL	11.18.2014
	SITE PLAN REVIEW RESUBMITTAL	11.20.2014
	GRADING RESUBMITTAL	12.04.2014
	PLAN CHECK RESUBMITTAL	12.09.2014
	SITE PLAN REVIEW RESUBMITTAL	12.16.2014
	FIRE PREVENTION DIVISION RESUBMITTAL	12.18.2014
	SITE PLAN / OAK TREE REVIEW RESUBMITTAL	12.24.2014
	COUNTY SANITATION DISTRICT SUBMITTAL	01.06.2015
	LAND DEVELOPMENT DEPARTMENT SUBMITTAL	01.13.2015
	PERMIT SET	01.26.2015
	RETAINING WALL SUBMITTAL	02.09.2015
	FOUNDATION PERMIT SUBMITTAL	03.12.2015
	PLANNING FENCE REVISION SUBMITTAL	04.08.2015
	BS FENCE REVISION SUBMITTAL	05.11.2015
	DRIVEWAY SUBMITTAL	12.08.2015

PROJECT TITLE:

CALLOW RESIDENCE

1200 E. WOODBURY RD. ALTADENA, CA 91104


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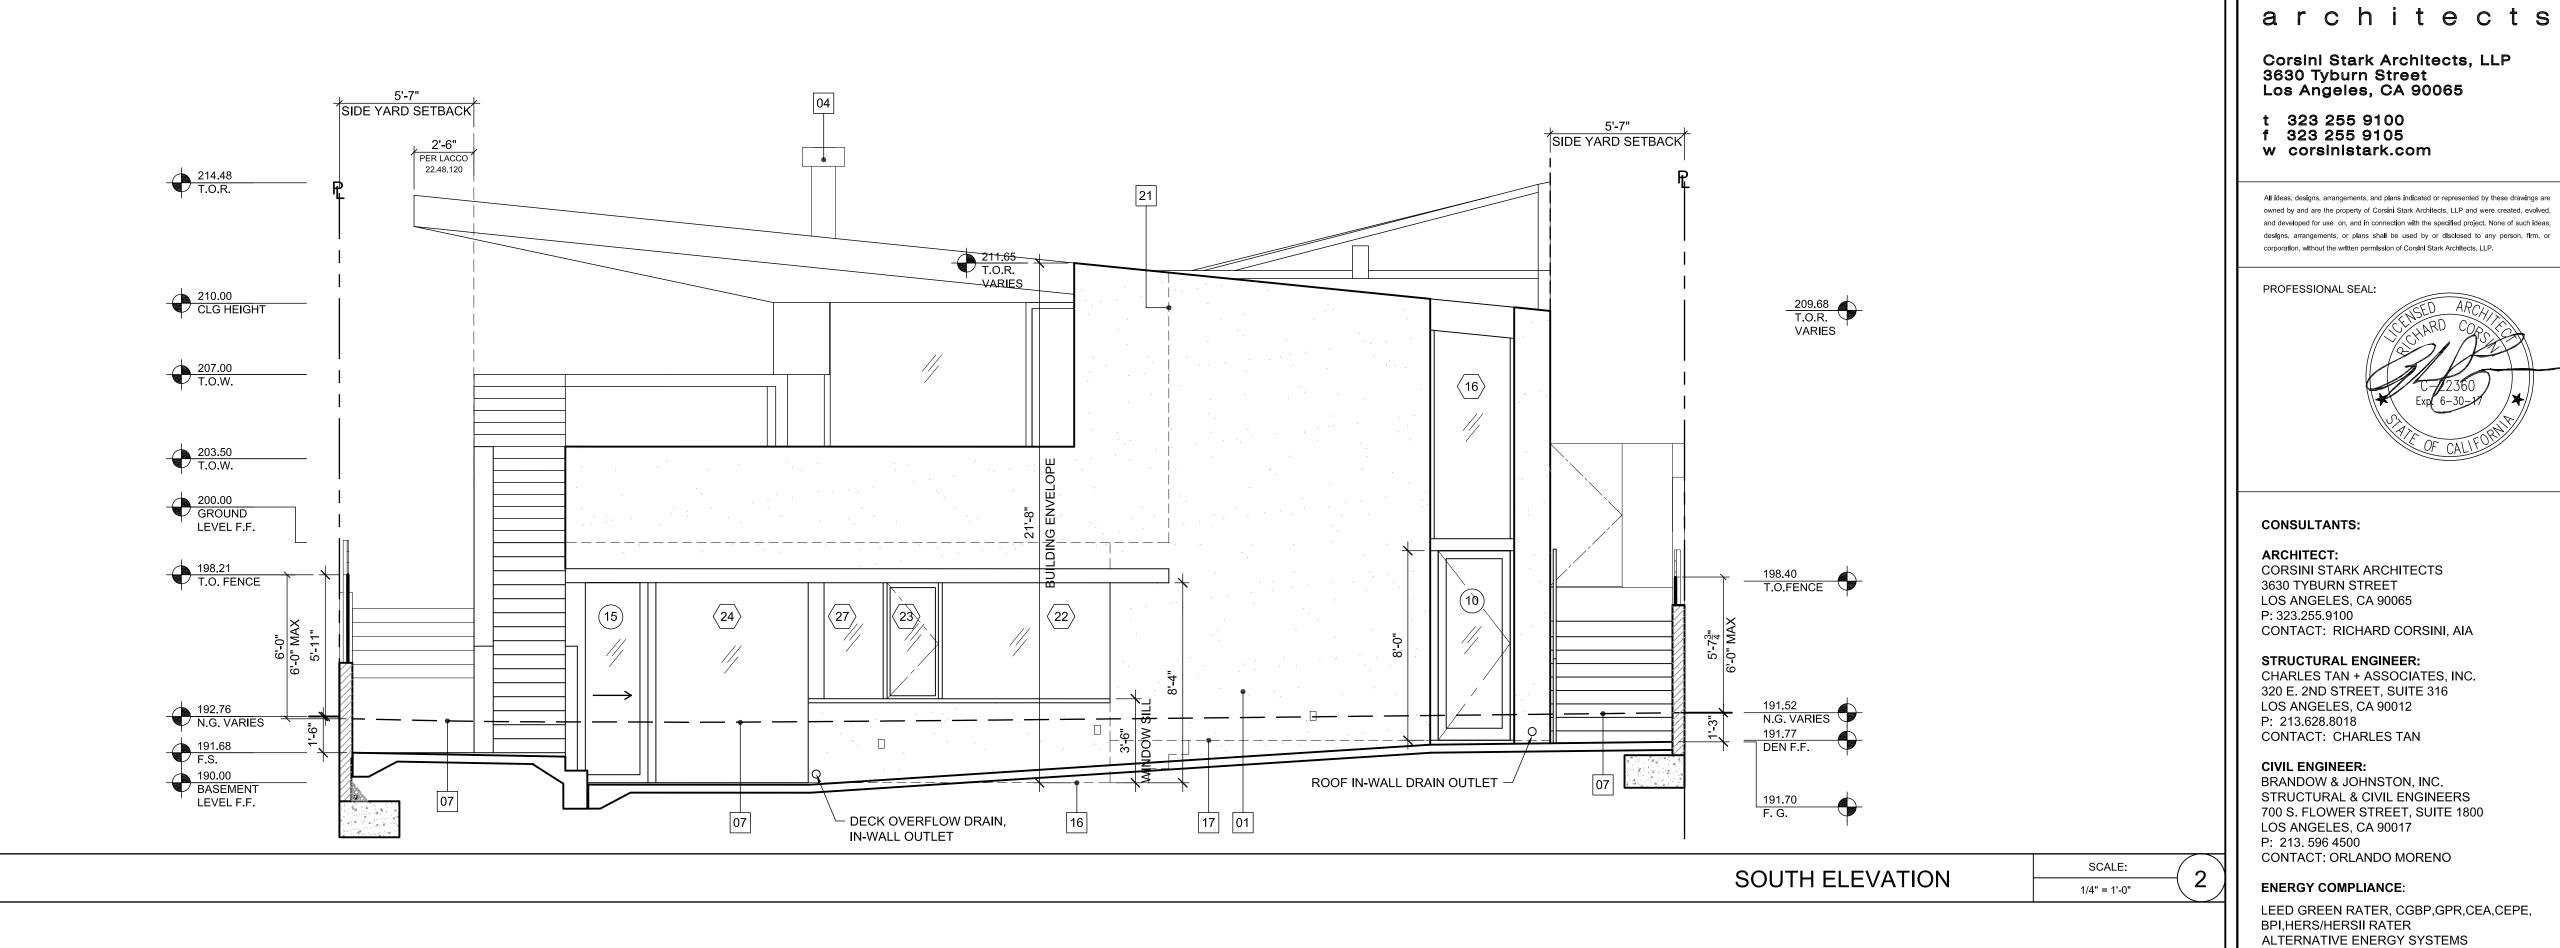
EXISTING CONDITIONS


DRAWING NUMBER:

A0.30

PROJECT 14.000.06



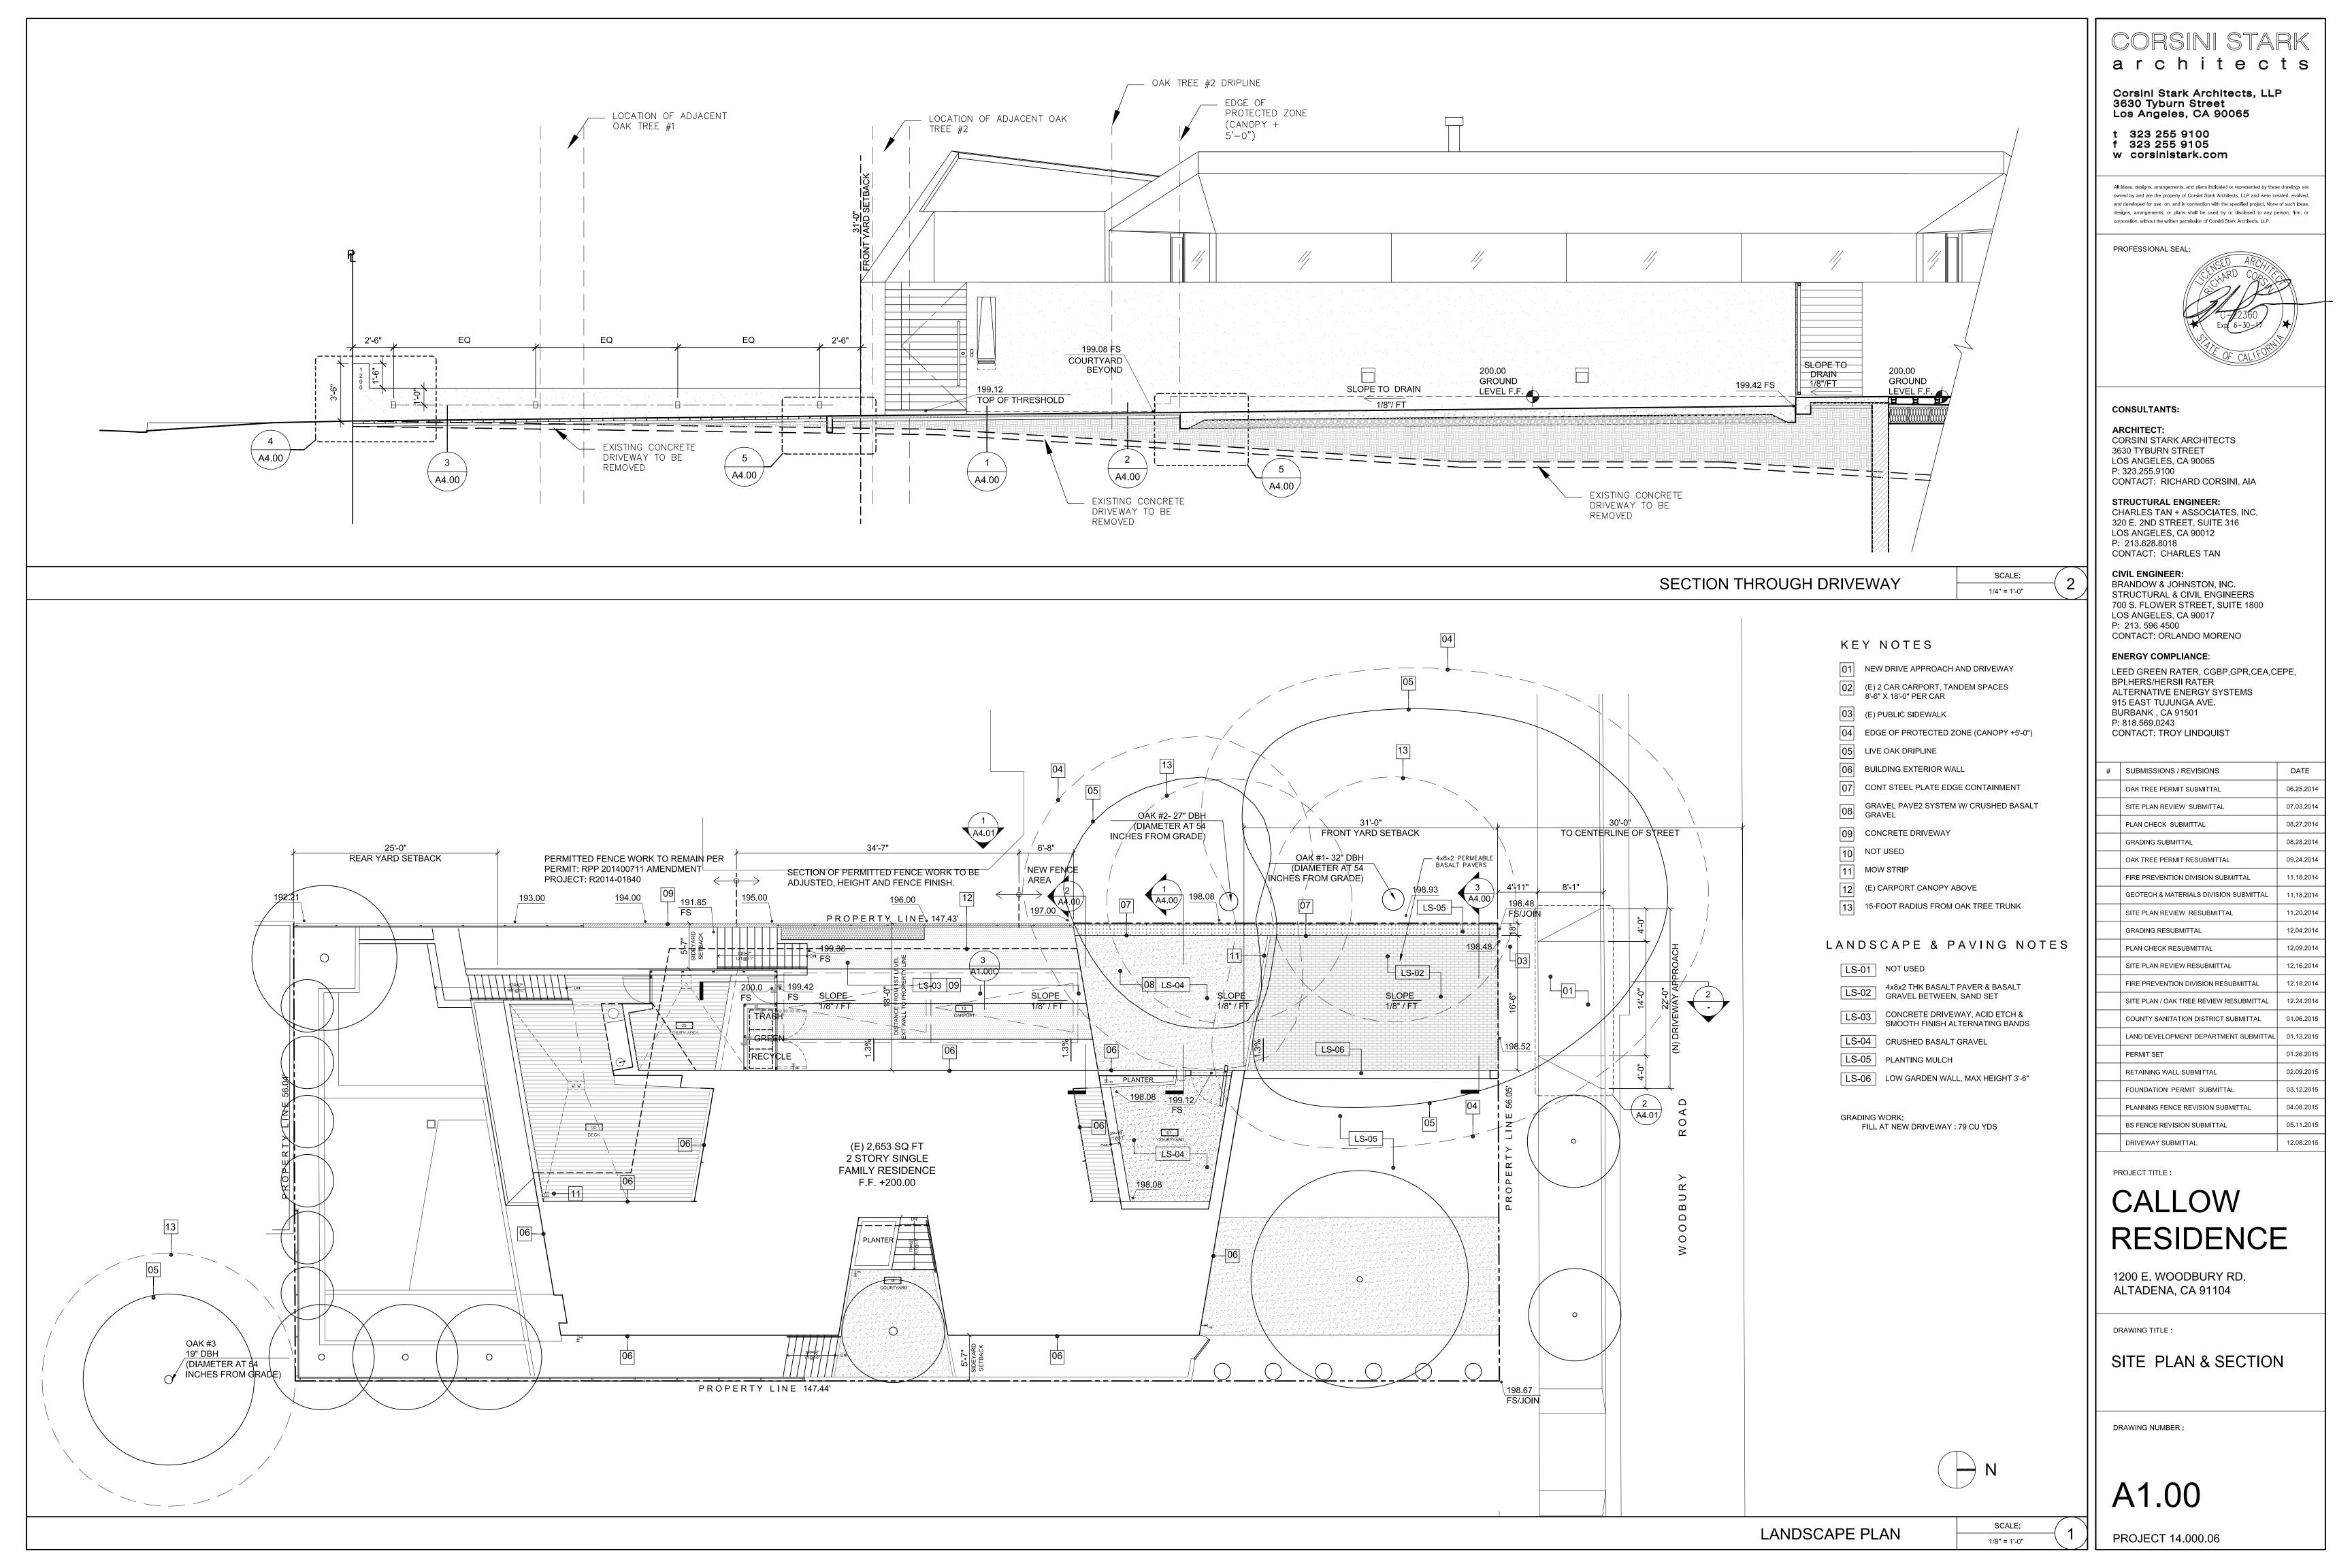

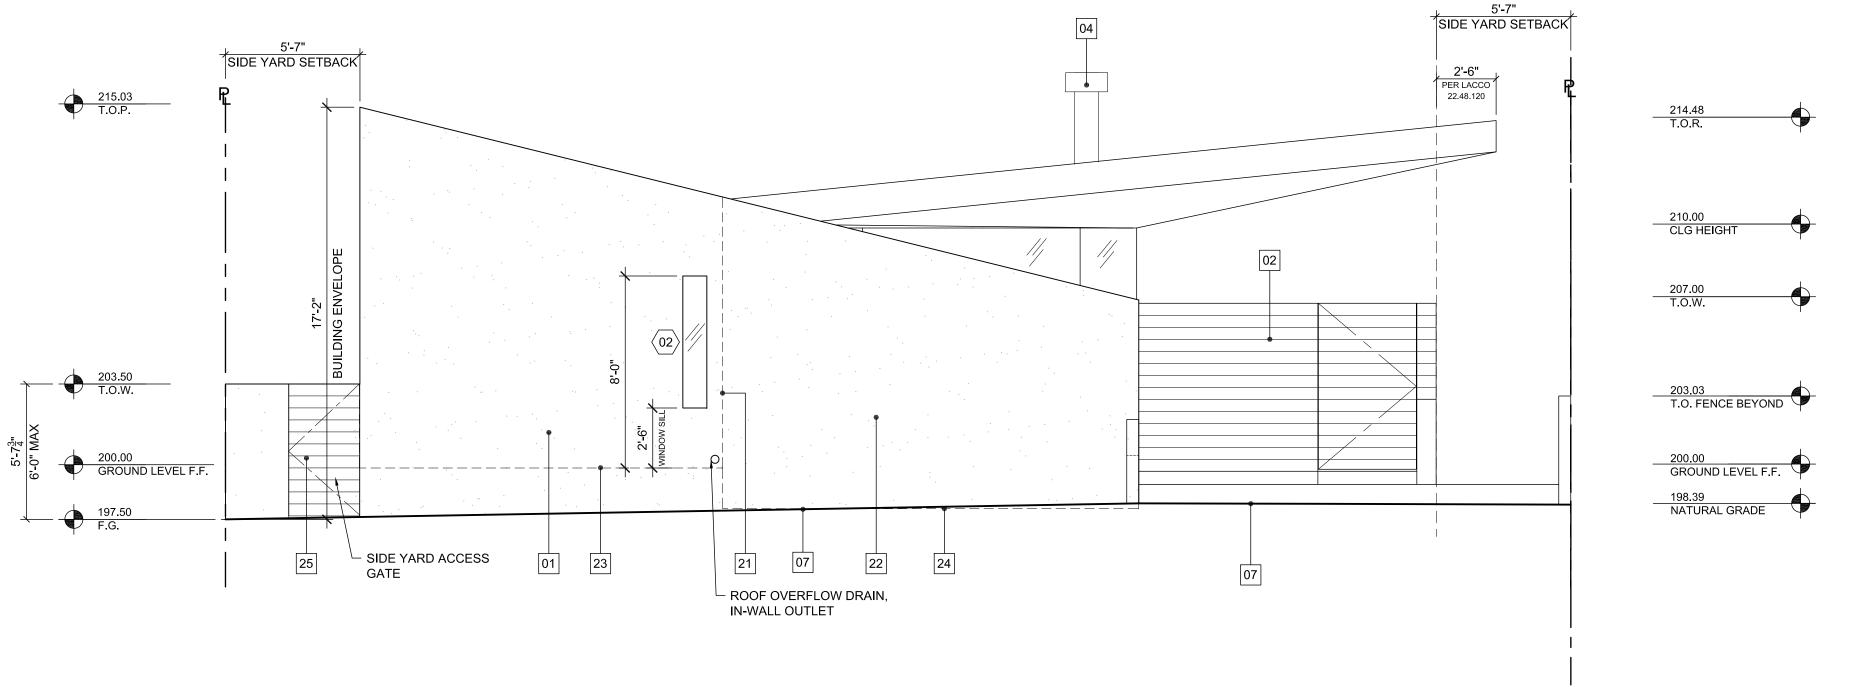

NORTH ELEVATION

SCALE:

1/4" = 1'-0"

1200 E. WOODBURY RD. ALTADENA, CA 91104

DRAWING TITLE:

EXTERIOR ELEVATIONS

RESIDENCE

CORSINI STARK

DRAWING NUMBER:

915 EAST TUJUNGA AVE. BURBANK, CA 91501 P: 818.569.0243

SUBMISSIONS / REVISIONS

CONTACT: TROY LINDQUIST

OAK TREE PERMIT SUBMITTAL

SITE PLAN REVIEW SUBMITTAL

OAK TREE PERMIT RESUBMITTAL

SITE PLAN REVIEW RESUBMITTAL

SITE PLAN REVIEW RESUBMITTAL

FIRE PREVENTION DIVISION RESUBMITTAL

SITE PLAN / OAK TREE REVIEW RESUBMITTAL

COUNTY SANITATION DISTRICT SUBMITTAL

LAND DEVELOPMENT DEPARTMENT SUBMITTAL 01.13.2015

GRADING RESUBMITTAL

PERMIT SET

PLAN CHECK RESUBMITTAL

RETAINING WALL SUBMITTAL

FOUNDATION PERMIT SUBMITTAL

BS FENCE REVISION SUBMITTAL

CALLOW

DRIVEWAY SUBMITTAL

PROJECT TITLE:

FIRE PREVENTION DIVISION SUBMITTAL

GEOTECH & MATERIALS DIVISION SUBMITTAL

PLAN CHECK SUBMITTAL

GRADING SUBMITTAL

06.25.2014

07.03.2014

08.28.2014

09.24.2014 11.18.2014

11.18.2014

11.20.2014

12.04.2014 12.09.2014

12.18.2014

01.06.2015

01.26.2015

02.09.2015


03.12.2015

04.08.2015

12.08.2015

A3.01

PROJECT 14.000.06

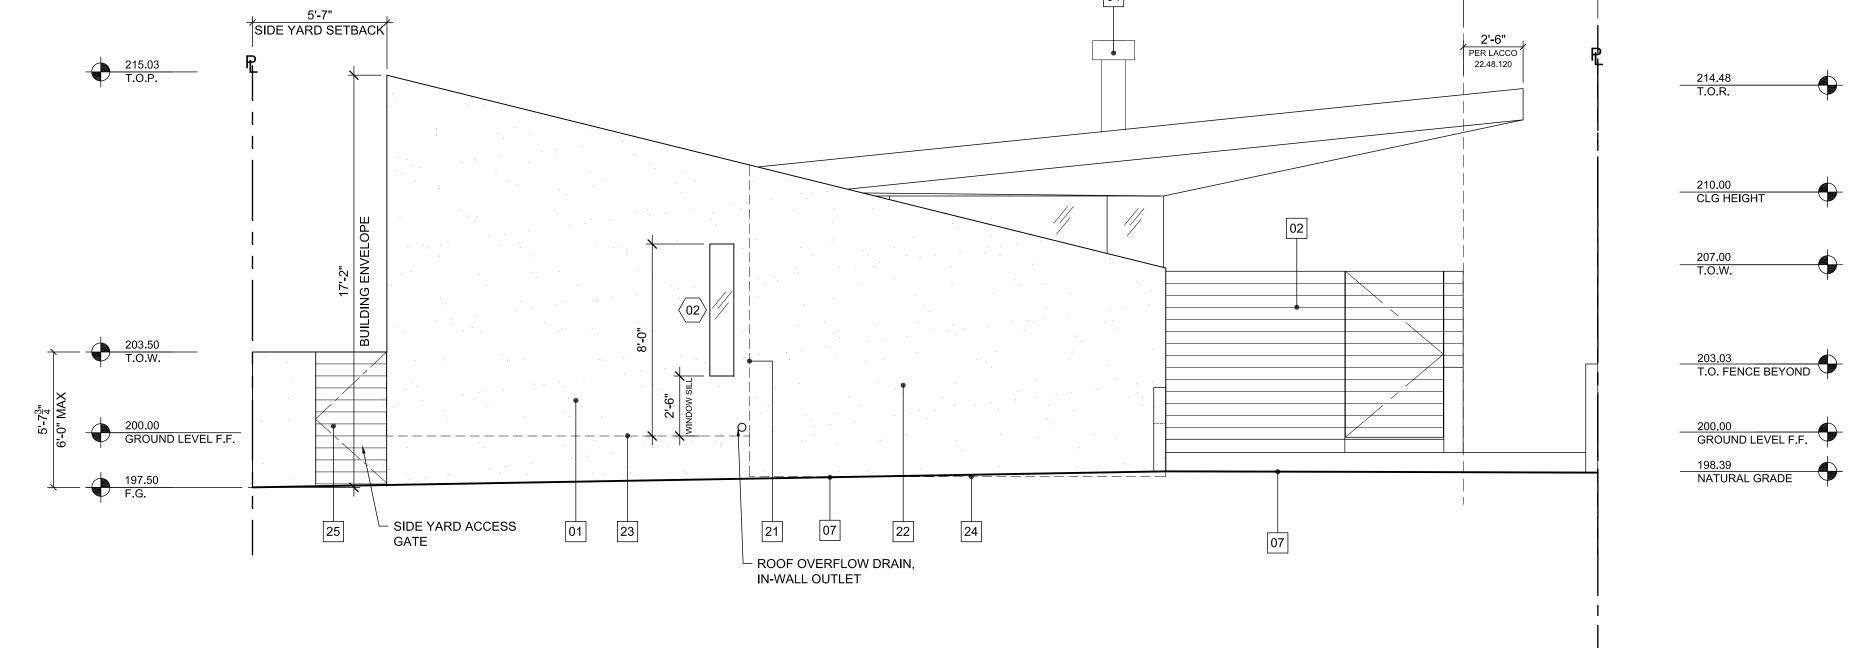

KEYNOTES

EXTERIOR CEMENT PLASTER 1x6 TONGUE & GROOVE DECKING OVER STEEL FRAME FENCE METAL GATE, PAINTED

CHIMNEY FLUE EXTERIOR CEMENT PLASTER O/ 6" CONCRETE BLOCK FENCE WALL, 1 SIDE & TOP ONLY, TOPPED W/ WOOD DECKING OVER 2"X3" STEEL FRAME

EXTERIOR CEMENT PLASTER O/ 6" CONCRETE BLOCK FENCE WALL, 2 SIDES & TOP,

LINE OF NATURAL GRADE COMPACT FILL

LINE OF PERMITED DRIVEWAY NEW CONCRETE DRIVEWAY

LINE SHOWING LOCATION OF ADJACENT OAK TREE #2

LINE OF OAK TREE #2 DRIPLINE LINE OF 5'-0" PROTECTION ZONE AREA CMU FENCE TOP: CUMARU DECKING FASTENED TO 2x2 STEEL TUBE W/ COUNTERSUNK BOLT

LINE OF NEW FINISH GRADE/SURFACE BEYOND FENCE LINE OF BASEMENT LEVEL F.F. BEYOND

LINE OF DEN F.F. BEYOND

LINE OF MECH. BASEMENT F.F. BEYOND RAISED PLANTER

RECESSED STAINLESS STEEL MAIL BOX LINE OF EXTERIOR WALL BEYOND EXTERIOR WALL, ENTRY COURTYARD ENCLOSURE

LINE OF GROUND LEVEL F.F. BEYOND LINE OF ENTRY COURTYARD F.F.

1x6 TONGUE & GROOVE DECKING OVER STEEL FRAME GATE, PAINTED TO MATCH ADJACENT WALL

